


PETITION # AA08-02


SECTION(S): 15

T. 25 S.

R. 16 E.

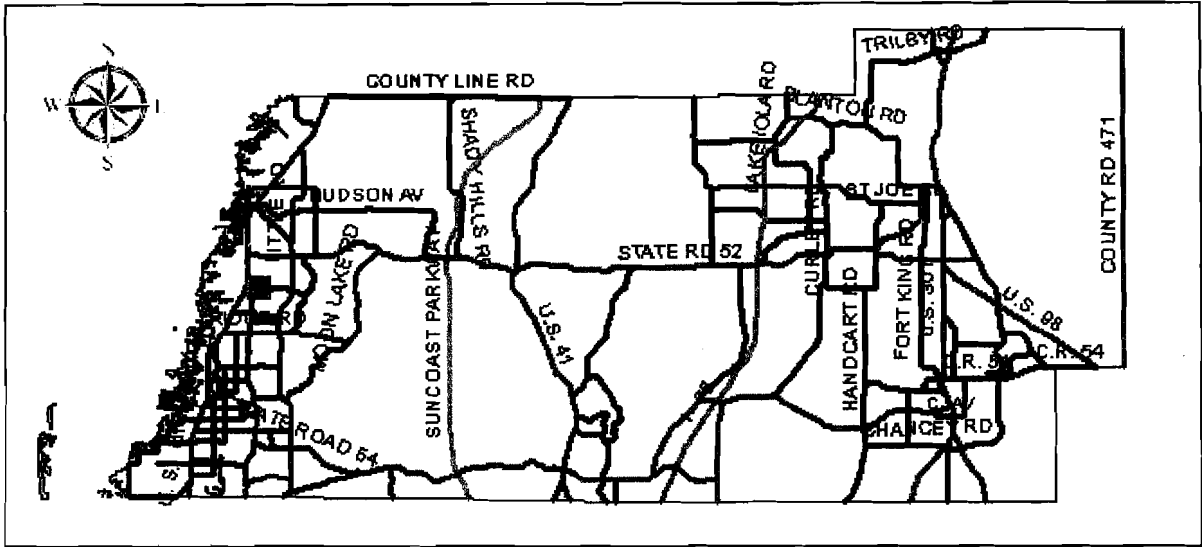

PASCO COUNTY, FLORIDA

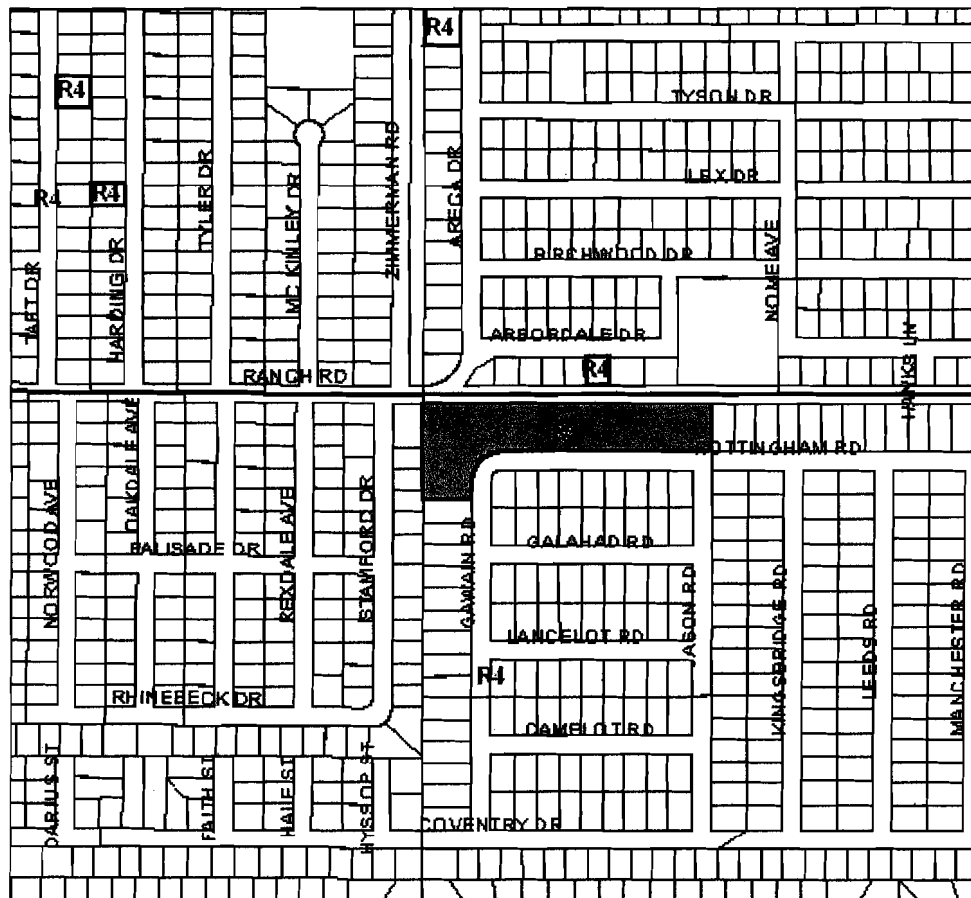

TAZ: 4


COMMISSION DISTRICT: 5

PETITION # AA08-02


SECTION(S): 15

T. 25 S.

R. 16 E.

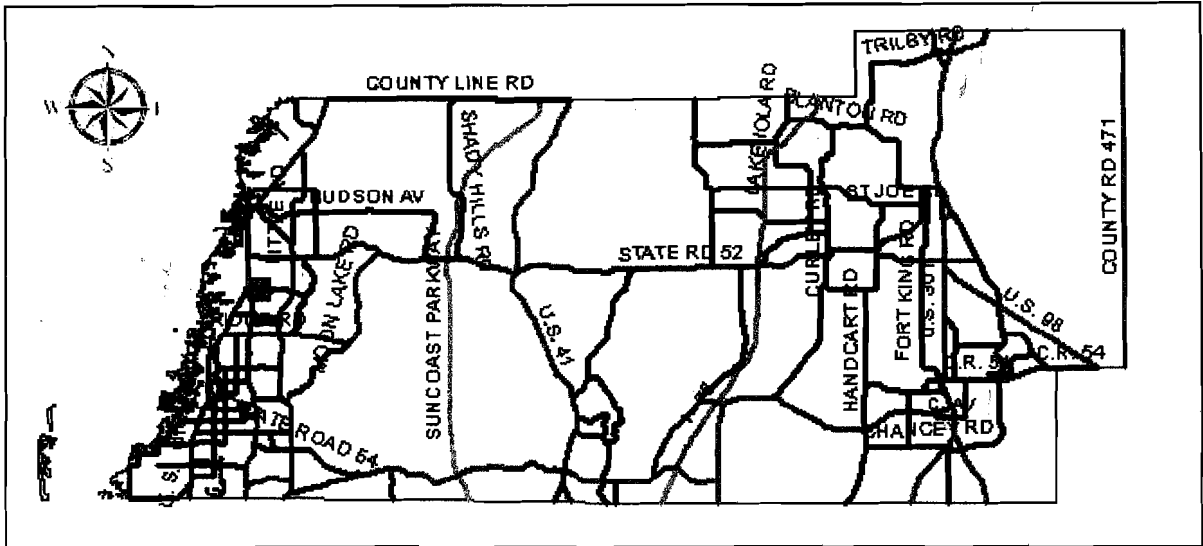

PASCO COUNTY, FLORIDA

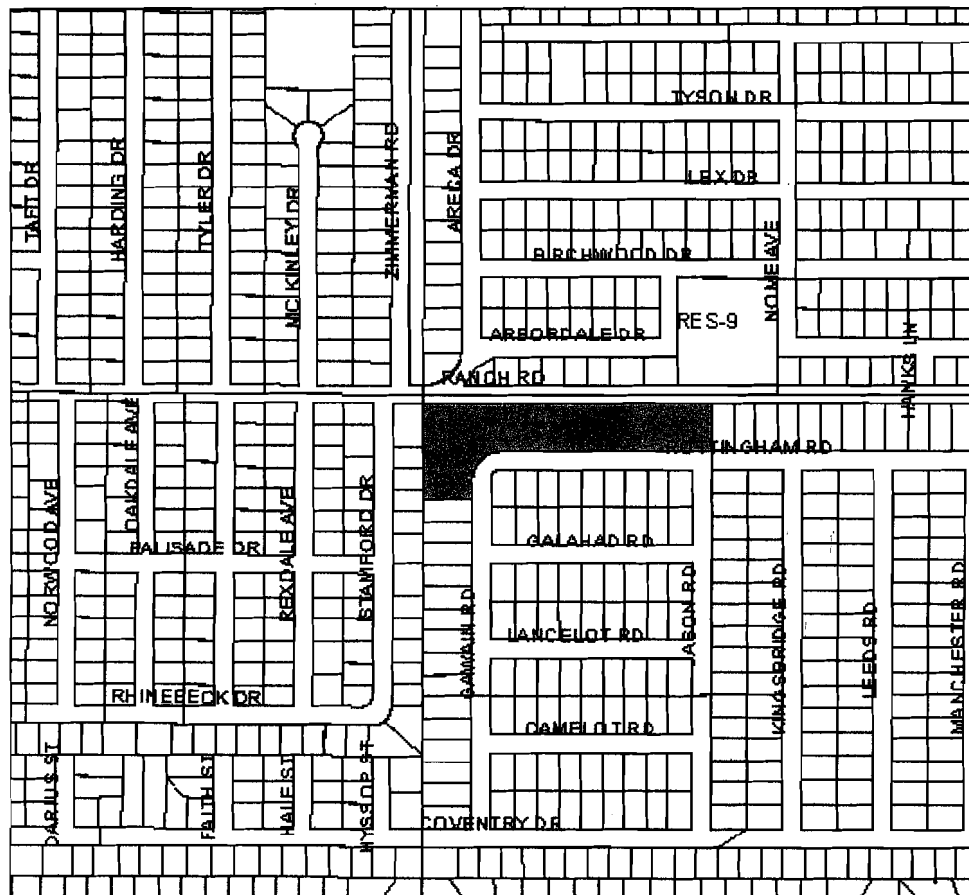

TAZ: 4


COMMISSION DISTRICT: 5

PETITION # AA08-02

SECTION(S): 15

T. 25 S.

R. 16 E.

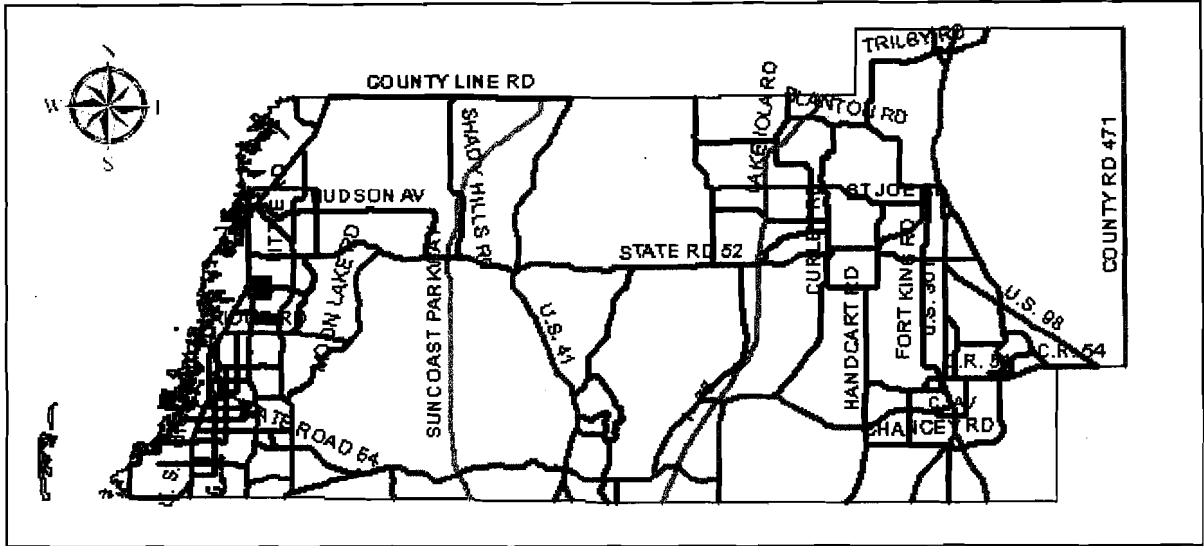


PASCO COUNTY, FLORIDA



TAZ: 4

COMMISSION DISTRICT: 5

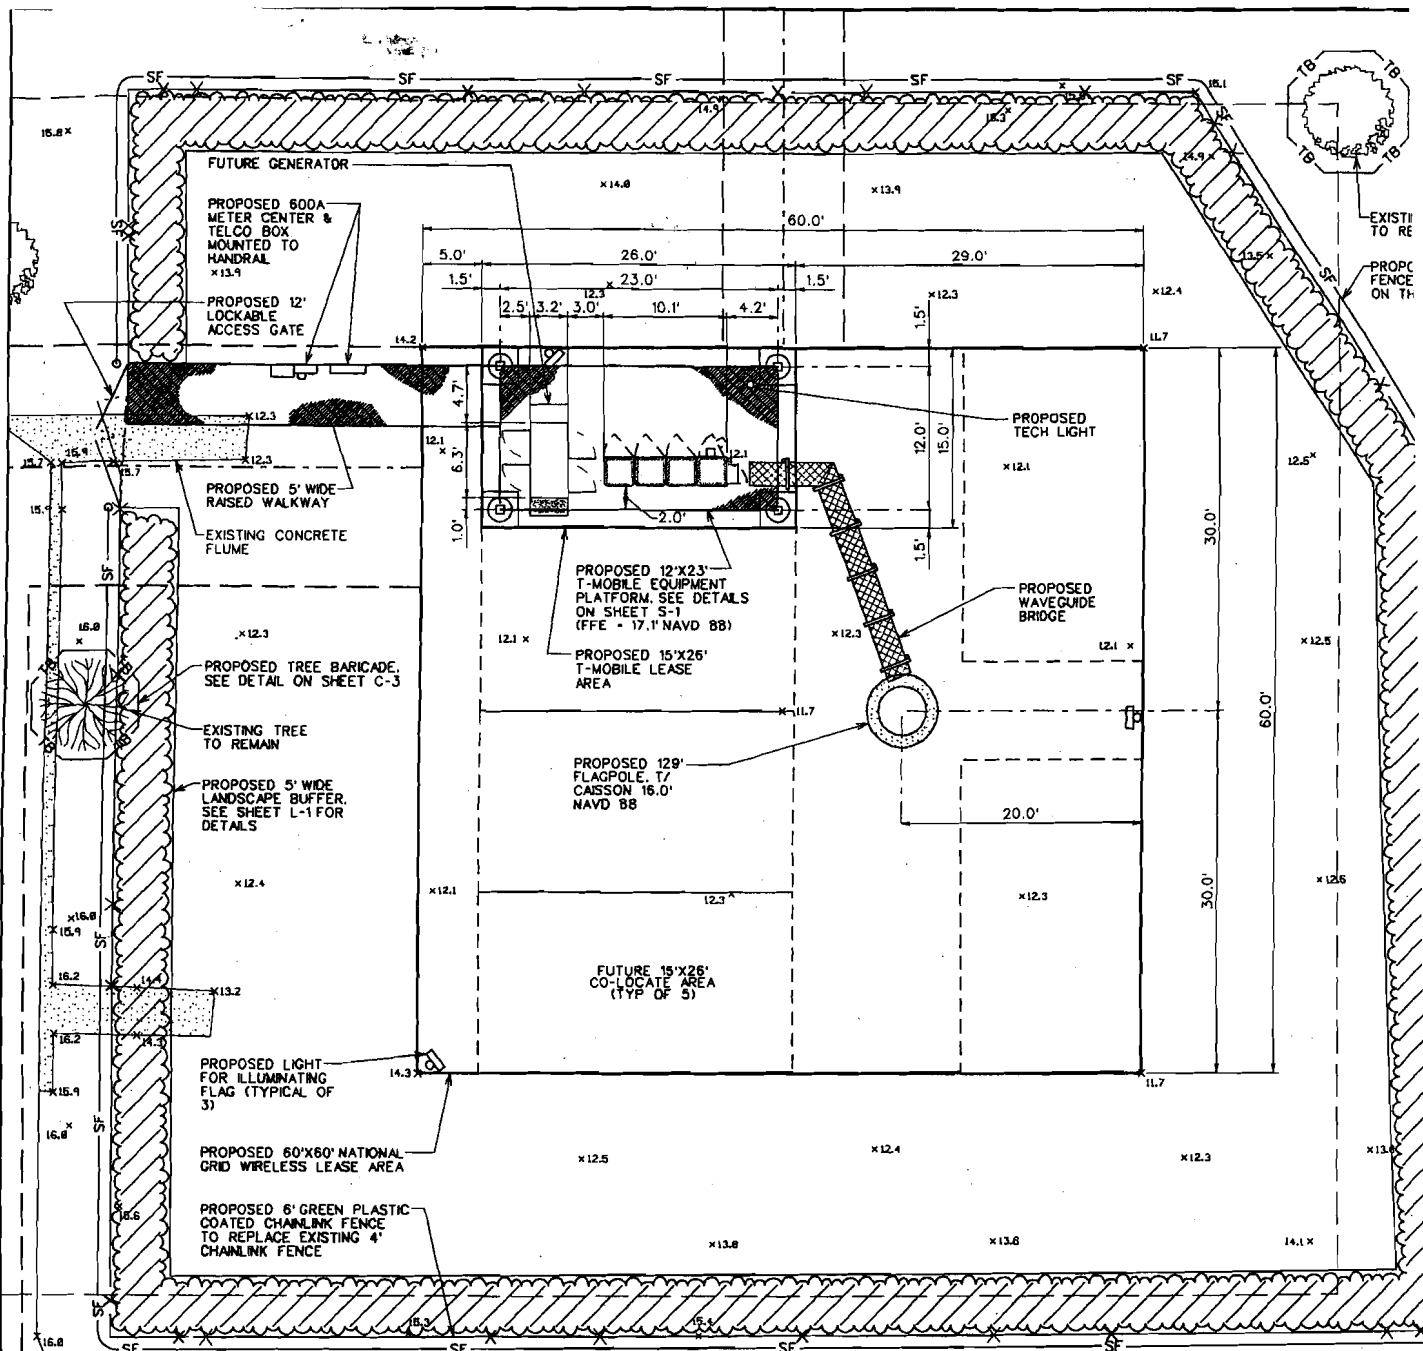

SITE DATA

1. PARCEL ID NUMBER: 15-25-18-0010-00600-0000
 ZONING: R4
 JURISDICTION: PASCO COUNTY
 PARENT TRACT TOTAL ACREAGE: 2.79 ACRES
 NATIONAL GRID LEASE AREA: 3800 SF
 T-MOBILE LEASE AREA: 390 SF
 PROPOSED IMPERVIOUS AREA: 42 SF (±)
 PROPERTY OWNER: CARES
 7505 ROTTINGHAM ROAD
 PORT RICHEY, FL 34668
 PROPERTY CONTACT: CHARLES SOBEL, MANAGER
 727-882-9291
2. VEHICULAR USE:
 APPROXIMATE ONE TO THREE SITE VISITS PER MONTH.
3. WATER AND SEWER:
 COMMUNICATION FACILITY SHALL NOT BE SERVICED BY WATER OR SEWER.
4. USE:
 UNMANNED TELECOMMUNICATIONS RELAY EQUIPMENT.
5. STORM WATER MANAGEMENT:
 SITE SHALL COMPLY WITH ALL STATE AND LOCAL JURISDICTION STORM WATER REGULATIONS.
6. PROPOSED ANTENNA INSTALLATION SHALL NOT INTERFERE WITH NORMAL RADIO AND TELEVISION RECEPTION IN THE VICINITY.
7. INFORMATION FOR CONSTRUCTION PLANS TAKEN FROM A SURVEY COMPLETED BY

COMPOUND DETAIL
 SCALE AS NOTED



8. IN THE EVENT THAT PWSF IS NOT OPERATED FOR A CONTINUOUS PERIOD OF EIGHTEEN (18) MONTHS, IT SHALL BE CONSIDERED ABANDONED, AND THE OWNER OF SUCH PWSF SHALL REMOVE SAME WITHIN NINETY (90) DAYS OF NOTICE TO THE PASCO COUNTY ADMINISTRATOR OR HIS DESIGNEE THAT THE PWSF IS ABANDONED. IF SUCH PWSF IS NOT REMOVED WITHIN SAID NINETY (90) DAYS, PASCO COUNTY MAY HAVE THE PWSF REMOVED AT THE PWSF'S OWNER'S EXPENSE.
9. NO EQUIPMENT SHALL BE OPERATED AT A PWSF SO AS TO PRODUCE NOISE IN EXCESS OF THE APPLICABLE NOISE STANDARDS UNDER THE PASCO COUNTY CODE OF ORDINANCES, ARTICLE IV, CHAPTER 68, AS AMENDED.
10. PWSF SHALL NOT BE ARTIFICIALLY LIGHTED.
11. NO SIGNAGE EXCEPT EMERGENCY INFORMATION AND A WEATHER-PROOF PLAQUE MOUNTED AT EYE LEVEL AT OR NEAR THE PWSF OR MOUNT IDENTIFYING THE CARRIERS AND DATES OF PERMIT APPROVAL FOR ALL ANTENNAS ON THE MOUNT AND THE LOCATION OF THE COUNTY OFFICE WHERE FURTHER INFORMATION CAN BE OBTAINED.
12. SETBACKS: TOWER AND EQUIPMENT PLATFORM TO PARCEL LINES

TOWER:	EQUIPMENT PLATFORM:
NORTH 80.4'±	NORTH 51.9'±
SOUTH 53.3'±	SOUTH 69.8'±
EAST 50.1'±	EAST 61.6'±
WEST 695.8'±	WEST 662.3'±
13. THE PROPOSED TOWER IS LOCATED IN AN AREA IN WHICH PEOPLE DO NOT CONGREGATE NOR ARE THERE HABITABLE STRUCTURES.
14. THE TOWER HAS A FALL ZONE RADIUS OF 50'.

PROVIDE 1" TUCK WITH ROPE IN THE HEM.

FENCE POSTS SHALL BE ROUGH 2 1/2" X 2" (NOMINAL) OR 2 1/2" DIA OR SCHEDULE 40 METAL PIPE OF MINIMUM STANDARD T OR U SEC 5" MINIMUM LENGTH. DRIVEN 18" INTO GROUND.

GEOTEXTILE (CLASS F)

EMBED APPROX 8" OF GEOTEXTILE BACKFILL TRENCH WITH EARTH. COMPACT THOROUGHLY. TRENCH APPROX. 4" DEEP X 6" WIDE

AA08-02








NOTE: ALL TO SHOWN

NOTE:
TOP OF BALL TO
NOT EXCEED 130'

16 12 8 4 0 8 16

FOR 24"x36" DRAWINGS
GRAPHIC SCALE: 1/8" = 1'-0"

FOR 11"x17" DRAWINGS
GRAPHIC SCALE: 1/16" = 1'-0"


-  T/ BALL = 130.0'
-  T/ FLAGPOLE = 129.0'
-  PROPOSED T-MOBILE ANTENNAS
RAD CENTER ELEV. = 125'
-  FUTURE ANTENNAS
RAD CENTER = 115.0'
-  FUTURE ANTENNAS
RAD CENTER = 105.0'
-  FUTURE ANTENNAS
RAD CENTER = 95.0'
-  FUTURE ANTENNAS
RAD CENTER = 85.0'

**TOWER WIND SPEED
DESIGN CRITERIA**

105 MPH SUSTAINED PER EIA/TIA-222-G
(EQUIVALENT TO 130 MPH 3-SEC GUST)
AS REQUIRED BY THE FLORIDA
BUILDING CODE

PROPOSED 129'
FLAGPOLE

TOWER COLOR TO
BE WHITE IN COLOR

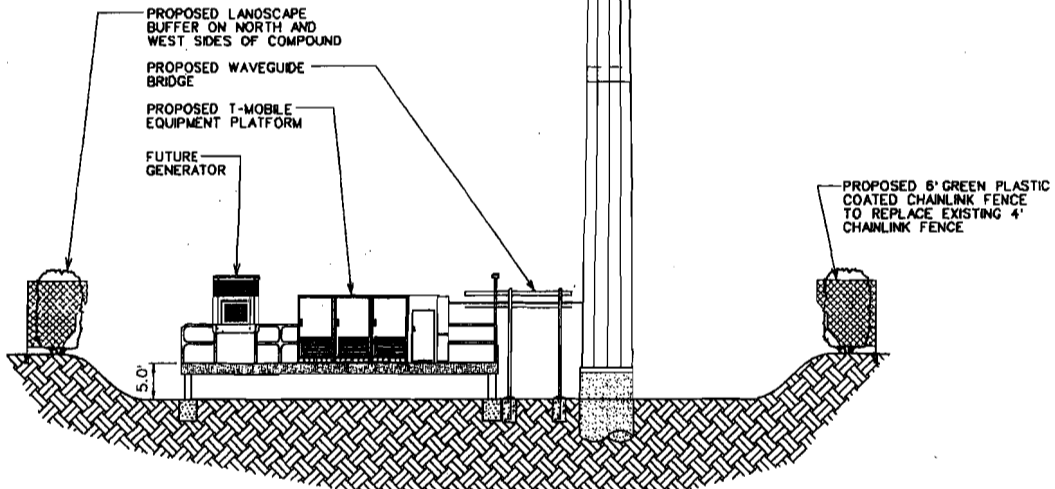


TOWER ELEVATION

NOTES:
1. ELEVATION SHOWN FOR REFERENCE
ONLY. DO NOT USE FOR DIMENSIONING.

SILT AND EROSION CONTROL PLAN NOTES:

1. GEOTEXTILE FABRIC TO BE FASTENED SECURELY TO FENCE POST BY WIRE TIES OR HOG RINGS. (3 FASTENERS PER POST)
2. ENDS OF INDIVIDUAL ROLLS OF GEOTEXTILE SHALL BE SECURELY FASTENED TO A COMMON POST OR OVERLAPPED 3' MINIMUM.
3. THIS DEVICE IS INTENDED TO CONTROL SHEET FLOW ONLY. IT WILL NOT BE USED IN AREAS OF CONCENTRATED FLOW WITH A DRAINAGE AREA OF 1/2 ACRE OR MORE.
4. ALL SILT FENCING SHALL BE INSTALLED PRIOR TO COMMENCING ANY LAND DISTURBING ACTIVITIES, AND SHALL REMAIN IN PLACE UNTIL ALL CONSTRUCTION ACTIVITIES ARE COMPLETED.

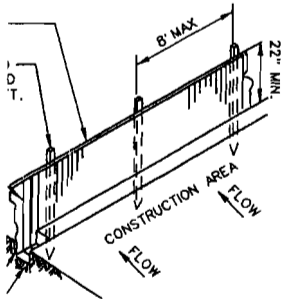

SILT FENCE DETAIL
NOT TO SCALE

NO.	DATE	DESCRIPTION	BY:
1	05/07/07	DESIGN FOR A REVIEW	DR
2	06/04/07	REVISED PRELIM CONST DRAWINGS	DR
3	07/16/07	REVISED PRELIM CONST DRAWINGS	DR
4	07/18/07	FINAL CONSTRUCTION DRAWINGS ISSUED	DR

DRAWN BY: D. REVELS
CHECKED BY: J. FENNEL
APPROVED BY: J. FENNEL

KCI
TECHNOLOGIES
FLORIDA LICENSE NO.: EB000498
KCI TECHNOLOGIES, INC.
10401 HIGHLAND MANOR DRIVE
TAMPA, FLORIDA 33610
(813) 740-2300

nationalgrid
Wireless
60 CENTRAL STREET
BOXBOROUGH, MA 01719
FL-0702

T-Mobile
3407 W. DR. MARTIN LUTHER KING BLVD
TAMPA, FL 33607
A2G765-A
CARES

ENGINEER:
TULLIO REVOLLO, PE
FL LICENSE NO.:
84064

THIS DRAWING IS THE PROPERTY OF THE SURVEYOR/ENGINEER AND MAY NOT BE USED OR REPRODUCED WITHOUT HIS/HER EXPRESSED WRITTEN PERMISSION.

SCALE: AS NOTED
DATE: 05-04-07
KCI JOB NUMBER: 10070009V

SHEET TITLE
**COMPOUND DETAIL
&
TOWER ELEVATION**

SHEET
AA08-02

Handwritten signature and date: [Signature] 07-20-07